




DRAWING NUMBERING KEY

SHOP DRAWING
MC02 - A - 0000
 BLDG. REF. LAYOUT NUMBER
 DISCIPLINE

- NOTES:-**
- FOR LEGEND, ABBREVIATION AND DETAILS INSTALLATION REFER TO DWG (GP001-GP003).
 - EXACT ROUTE AND LOCATION OF EACH PIPELINE SHALL BE DETERMINED IN COORDINATION WITH OTHER TRADES PRIOR TO INSTALLATION.
 - BOTTOM LEVEL OF THE PIPE MEASURED FROM TOP ELEVATION (+00.00).
 - FOR ALL SITE WORKS DETAILS, MATERIAL AND EQUIPMENT MUST BE AS SUPPLIER APPROVED AND DETAILED BOQ
 - ALL SHOP DRAWING WORKS IS ACCORDING TO AVAILABLE AND APPROVED DESIGN AND ANY MISSING INFORMATION REFER TO APPROVED DESIGN
 - ALL PIPES INSTALLATION STANDARD DETAILS MUST BE APPLIED AND FOLLOWED DURING INSTALLATION WORKS ACCORDING TO APPROVED MANUFACTURER OR SUPPLIER, SITE LEVELS AND CONDITIONS.
 - LOCATION X&Y MUST BE AS PER APPROVED COORDINATE
 - THE CONTRACTOR SHOULD CONNECT ALL PIPING LAYOUT ACCORDING TO APPROVED DESIGNED SERVICE TUNNEL DETAILS
 - ALL SITE WORKS ROUTING, LEVELS...ETC IS ACCORDING TO APPROVED DESIGN.
 - FOR SITE SETTING OUT AND GRADING LEVEL AT PARKING LEVEL REFER TO DWG. MC03-XC-01.
 - UNLESS OTHERWISE INDICATED ALL DIMENSIONS, COORDINATES AND ELEVATIONS ARE IN METERS.
 - NORTHING AND EASTING COORDINATES ARE BASED ON MAGNETIC NORTH.
 - FOR POINT COORDINATES REFER TO DWG (XC-PNT).
 - FOR EXTERNAL WATER SUPPLY REFER TO DWG MC06-MECH-R034 (REV 0).

NO.	DATE	CAD BY	CHKD.	REVISIONS	STATUS	DATE

KEY PLAN

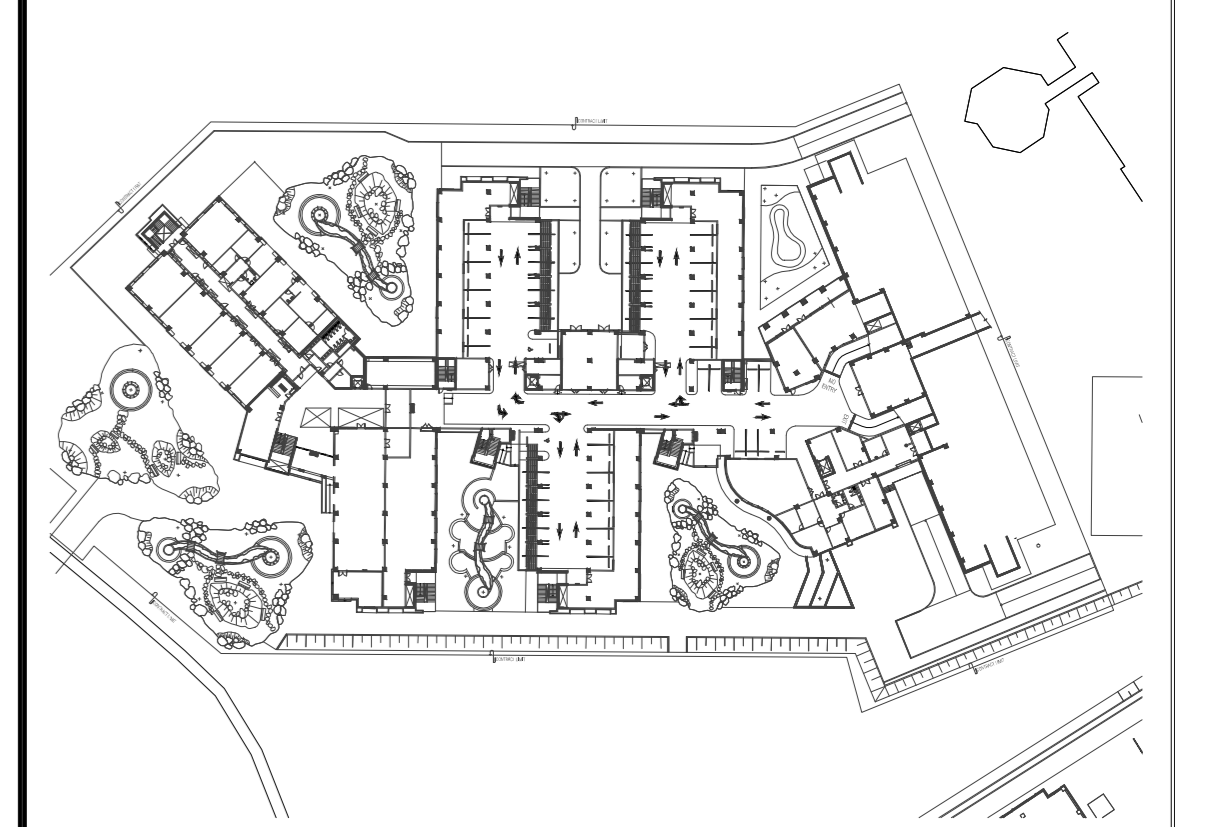

BLDG REF. MC03

CONSULTANTS :

NAMAA Consult
 "INNOVATIVE INTEGRATION"

SHOP DRAWING

DESIGN REF. NO.: **XP-02**
 SD REF. NO.:

DRAWING TITLE **EXTERNAL WORK DRAWINGS**
PARKING LEVEL WATER SUPPLY

ARCH	CIVIL/STRUCT.	ELECT.	MECH.	ENGG. MGR.	DATE
					24/11/2012

SCALE: 1:100

TRANSMITTAL NO. MC03- DWG. NO. MC03-XP-P12 REV. NO. 1